

SPECIFICATION: WORK TOP

: Laminated Wood Finish : 25mm Thk Table Top : Metal leg dark gray finish : 1.50(L) x 0.60(W) x 0.75(H) : 0.90(L) x 0.45(W) x 0.75(H)

: L-Shaped with Damper

ACC's

: Keyboard Tray(ABS) PVC Gray : Mobile Pedestal - Gray Finish

PANEL

: Fabric Glass Stripe Partition : 42mm Thk x 1.50(H) x 1.50(L)

: Charcoal Gray Aluminum Endtrims

: With Midraceway and Baseboard


QUANTITY :

2 sets

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LOCATION:

EXECUTIVE AREA

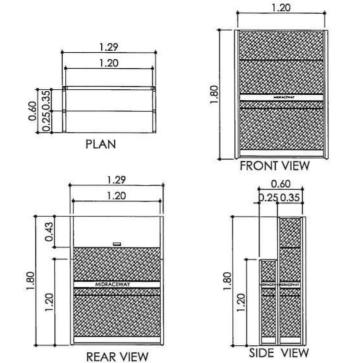

SPECIFICATION :WORK TOP

: Laminated Wood Finish

: 25mm Thk Table Top : 1.20(L) x 0.60(W) x 0.75(H)

ACC's : Keyboard Tray(ABS) PVC Gray

PANEL

: Fabric Partition

: 42mm Thk x 0.25(L) x 1.20(H)

: 42mm Thk x 0.35(L) x 1.80(H) : 42mm Thk x 1.20(L) x 1.80(H)


: Charcoal Gray Aluminum Endtrims

: With Midraceway and Baseboard

QUANTITY

3 sets

LOCATION : STAFF AREA

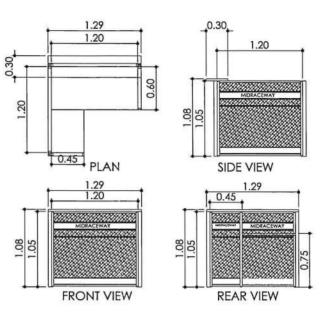

SPECIFICATION: WORK TOP

: L-Shaped

: Laminated Wood Finish : 25mm Thk Table Top

: 1.20(L) x 0.60(W) x 0.75(H)

: 0.70(L) x 0.45(W) x 0.75(H)

COUNTER TOP

: Laminated Wood Finish : 25mm Thk Table Top

: 1.29(L) x 0.30(W)

ACC's

: Keyboard Tray(ABS) PVC Gray : Mobile Pedestal - Gray Finish

PANEL : Fabric Partition

: 42mm Thk x Vary(L) x 1.05(H)

: Charcoal Gray Aluminum Endtrims : With Midraceway and Baseboard

QUANTITY

: 1 set

LOCATION

RECEPTION AREA





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PLANNING
DEVELOPMENT &
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AR. ROSANE G. FLORES-BERNARDO
CHIEF, CPDIMO

PREPARED BY:

AR. JEFFREY O. BATAYOLA
ARCHITECT II

PROPOSED SUPPLY & INSTALLATION
OF OFFICE FURNITURE - OVCA

PROJECT TITLE :

OF OFFICE FURNITURE - OVCA
OFFICE OF THE VICE CHANCELOR FOR ADMINISTRATION
8TH FLOOR CENTRAL BLOCK, PGH COMPLEX
UNIVERSITY OF THE PHILIPPINES MANILA

MICHAEL L. TEE, MD, MHPEd, MBA
VICE CHANCELOR FOR PLANNING AND DEVELOPM



ARLENE A. SAMANIEGO, MD
VICE CHANCELLOR FOR ADMINISTRATION

APPROVED:

AS - SHOWN

BET NO.:

CADD BY:

LO.B

DWG FILE:

2 OF 3

GENERAL SPECIFICATIONS:

ALL WORKS SHALL COMPLY WITH THE PROVISION OF THE LATEST APPROVED EDITION OF THE PHILIPPINE ELECTRICAL CODE, WITH THE RULES AND REGULATIONS OF THE NATIONAL AND LOCAL AUTHORITY CONCERNED IN THE ENFORCEMENT OF ELECTRICAL LAWS AND ORDINANCES AND WITH THE RULES AND REGULATIONS OF THE UTILITY COMPANY AND WITH THE RULES AND REGULATIONS OF THE UTILITY COMPANY CONCERNED. WORK SHALL NOT BE STARTED UNLESS A VALID WIRING PERMIT HAS BEEN SECURED. 1. SERVICE VOLTAGE SHALL BE 230 VOLTS, 3 PHASE, 4 WIRES (LINE TO LINE) / 230V, 1PHASE, 3 WIRES.

- 2. GENERAL USE RECEPTACLES SHALL BE RATED 16A, 250 VOLTS GROUNDING TYPE, HOSPITAL GRADE OUTLETS SHALL BE INSTALLED IN MEDICAL CARE AREAS.
- ALL RIGHT CONTROL SWITCHES SHALL BE RATED 16A, 120 177 VOLTS A.C. ONLY.
- 4. ALL FLUORESCENT LAMPS SHALL BE PROVIDED WITH LED TUBE AND SPRING LOADED LAMP HOLDER.
- CIRCUIT REFAKER SHALL BE ILS MADE "G E " OR "SQUARE D"
- PRESSED STEEL OUTLET BOXES SHALL BE GALVANIZED, GA. #16 MINIMUM. AS FOLLOWS:

a. CEILING LIGHT OUTLET - 40MM DEEP, 100MM OCTAGONAL

b. WALL SWITCHES

BOX FOR 1 OR 2 RACEWAY
BOX FOR 1 OR 2 RACEWAY
ENTRIES.

- 55MM DEEP UILITY BOX FOR
1 OR 2 RACEWAY ENTRIES
40MM DEEP, 100MM SQ, BOX
WITH 1-GANG RAISED COVER

C. WALL RECEPTACLE

FOR 3 SWITCHES ON STRAP 1 OR 2 RACEWAY ENTRES.

40MM DEEP, 100MM SQ. BOX
WITH 1-GANG RAISED COVER OR

AS REQUIRED BY THE DEVICE

7. MOUNTING HEIGHTS SHALL BE AS FOLLOWS:

a. LIGHT CONTROL SWITCH b. CONVENIENCE OUTLET

- 1.00M ABOVE FLOOR AT CENTER
- 0.30M ABOVE FLOOR AT CENTER
FOR NON-WEATHER PROOF OUTLET
0.30M ABOVE COUNTER AT CENTER FOR PANTRY.

LABORATORY OUTLETS SHALL BE 0.30M

ABOVE LAR TABLE - AS REQUIRED BY EQUIPMENT

c. SPECIAL PURPOSE OUTLET d. WALL TELEPHONE TV OUTLET

- AS REQUIRED BY EQUIPMENT UNLESS OTHERWISE REQUIRED BY FIELD CONDITION.
- 1.40M ABOVE FLOOR AT CENTER.

e. PANEL BOARDS, MTS


- ALL EXPOSED CONDUITS WITHIN THE BUILDING SHALL BE EMT. CONDUITS EMBEDDED IN CONCRETE SHALL BE THICK WALL PVC.
- REFER TO ARCHITECTURAL DRAWINGS FOR EXACT LOCATIONS OF LIGHTING FIXTURES, SPEAKERS AND OTHER WALL AND CEILING MOUNTED DEVICES ASSOCIATED WITH FIRE AND LIFE SAFETY SYSTEMS, ETC., ALSO REFER TO THE SPECIFICALLY DIMENSIONED OTHERWISE, DEVICES SHOWN ON ELECTRICAL DRAWING ARE GENERAL LOCATIONS AND ARE INDICATIVE OF TYPES AND
- REFER TO MECHANICAL, PLUMBING AND FIRE PROTECTION DRAWING FOR RAILINGS AND LOCATIONS OF EQUIPMENT AS WELL AS THEIR CONTROL SEQUENCES AS SPECIFIED AND/OR SHOWN UNDER THEIR RESPECTIVE SECTIONS.
- CONDUIT SLEEVE AND FLOOR SLOT PENETRATIONS THROUGH ELECTRICAL WALL AND TELEPHONE/CLOSET SPACES SHALL BE PROPERLY SEALED OFF WITH FIRE RETARDANT MATERIALS TO MAINTAIN FIRE RESISTIVE RAILINGS OF THE SPACES.
- PULL BOXES AND JUNCTION BOXES SHALL BE PROVIDED AS REQUIRED BY SPECIFICATION, CODES AND LOCAL UTILITY CO., STANDARDS FOR ALL CONDUIT RUNS.
- ALL CONCRETE WORKS AND RELATED STEEL REINFORCING INDICATED ON ALL CONCRETE WORKS AND RELATED STEEL REINFORCING INDICATED ON ELECTRICAL DRAWINGS AS IT RELATES TO MANHOLES, DUCT BANKS, CONCRETE ENCASEMENT, EQUIPMENT SERVICE PADS, ETC. SHALL BE PROVIDED BY THE CIVIL WORKS CONTRACTOR IN ACCORDANCE WITH THE REQUIREMENTS AND CRITERIA ESTABLISHED ON THE ELECTRICAL DOCUMENTS. ALSO REFER TO STRUCTURAL DRAWINGS FOR DETAILS OF SLEEVES AND BLOCK OPENINGS THROUGH FLOOR SLABS.
- PROVIDE ALL SUPPLEMENTARY SUPPORT STEEL IN CLOSETS, SHAFTS, PIPE PROVIDE ALL SOFTERMENTA SOFTERMENTS AND SUPPORT ELECTRICAL RACEWAYS AND EQUIPMENT. ALL ELECTRICAL WORKS SHALL BE SUPPORTED INDEPENDENTLY AND NOT ON INSTALLATIONS OF OTHER TRADES.
- ALL MATERIALS TO BE USED SHALL BE NEW INSTALLED IN APPLICATIONS FOR WHICH THEY ARE INTENDED.


- 9. ALL RECEPTACLE OUTLETS SHALL BE PROPERLY GROUNDED TO THE BOX BY MEANS OF GROUNDING LUGS.
- ALL MOUNTING HEIGHT ARE SUBJECT TO THE ARCHITECTS APPROVAL PRIOR TO INSTALLATION.
- 11. ALL PVC CONDUITS ARE SIZED BASED ON INSIDE DIAMETER
- 1.0 WIRING SHALL BE COLOR CODED.

FOR GROUNDED SYSTEM (230V): LINE 1 - RED LINE 2 - YELLOW LINE 3 - BLUE GROUND - WHITE

FOR ISOLATED SYSTEM (230V): LINE 1 - ORANGE LINE 2 - BROWN

2.0 WIRE NUTS SHALL BE USED FOR SPLICING OF WIRE NOT MORE THAN 8.0mm, FOR LARGER WIRES SOLDER LESS CONNECTOR SHALL BE USED INSULATED WITH RUBBER

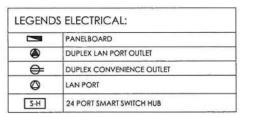

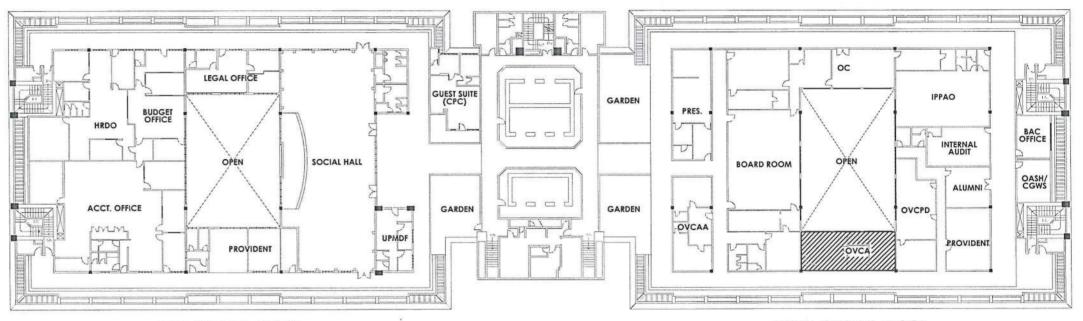

LEFT CENTRAL BLOCK

CENTRAL ADMINISTRATION (CAD), 8TH FLOOR, PGH

RIGHT CENTRAL BLOCK



PROJECT TITLE:

8TH FLOOR PLAN/KEY PLAN

RECOMMENDING APPROVAL

SCALE: NTS



CPDMO

CAMPUS PLANNING **DEVELOPMENT &** MAINTENANCE OFFICE

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ENGR. RENATO B. REMORQUE

AR, ROSAVE G. FLORES-BERNARDO

ENDORSED BY:

PROPOSED SUPPLY & INSTALLATION OF OFFICE **FURNITURE - OVCA**

MICHAEL L. TEE, MD, MHPED, MBA

ARLENE A. SAMANIEGO, MD

APPROVED:

DATE REVISED: AS SHOWN REVISION NO.: REF. NO.:

DATE ISSUED:


SHEET CONTENT:

E-1 1 OF 3

SHEET NO .:


SCOPE OF WORKS:

- SUPPLY AND INSTALLATION OF NEW POWER AND LAN PORT OUTLET
- 2. DISMANTLING OF EXISTING ELECTRICAL AND LAN COMPONENT
- 3. SELECTED OUTLET WILL BE TAP TO EXISTING CIRCUIT NEAR THE OFFICE FURNITURE (SEE SHEET E-2)
- 4. LOCATION OF THE SMART SWITCH HUB WILL BE AT THE DATA ROOM
- 5. SELECTED OUTLET WILL BE PROVIDED BY NEW CIRCUIT
- WIRE CABLES AT OVCA AND RECEIVING ROOM WILL BE EMBED
- WIRE CAABLES AT STAFF AREA WILL BE PLACED TO FURNITURE RACEWAY AND PVC MOUDLING
- 8. CHIPPING AND RESTORATION OF ALL AFFECTED AREAS DUE TO THE INSTALLATION OF UTILITIES INCLUDING REPAINTING
- 9. TESTING AND COMMISSIONING

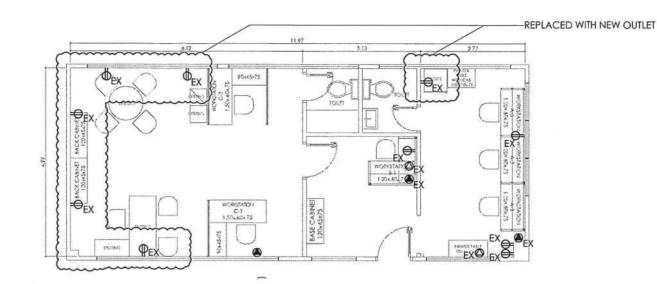

1 E-2 OVCA EXISTING POWER AND LAN LAYOUT


SCALE: 1:100MTS

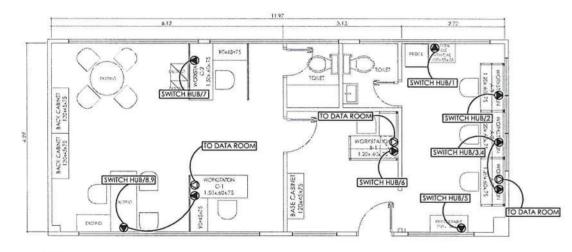

3 E-2

PROPOSED LAN & PABX LAYOUT

SCALE: 1:100MTS

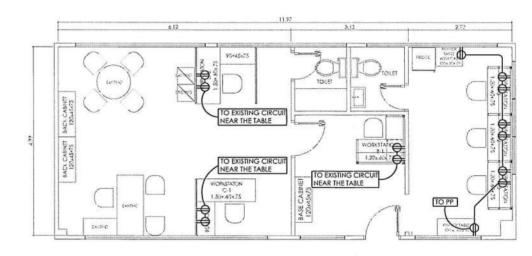


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PROPOSED POWER LAYOUT

SCALE: 1:100MTS





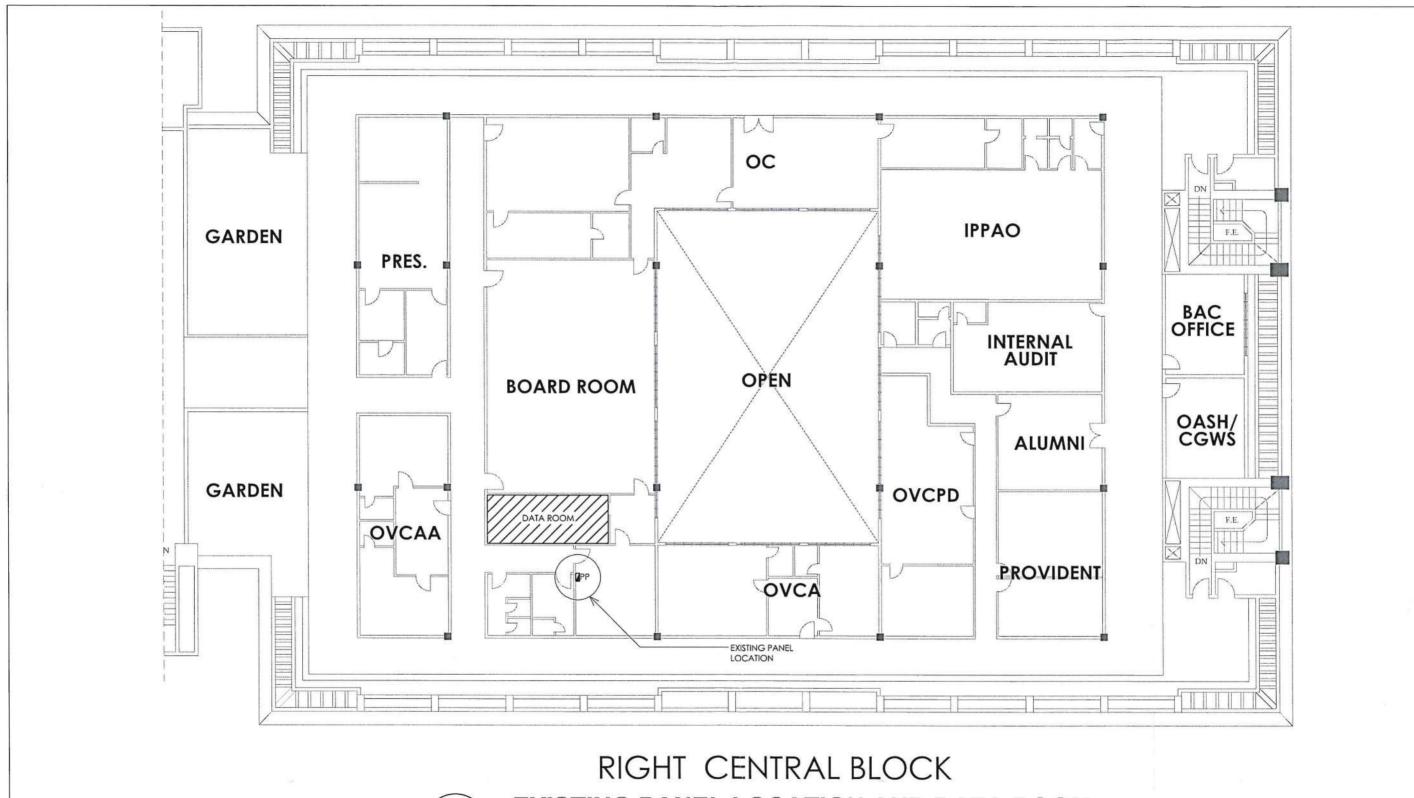

EXISTING PANEL LOCATION AND DATA ROOM

SCALE: NTS

